



WINDOW GENERAL NOTES

- ALL WINDOW SIZES ARE TO FRAME OPENINGS OR EXISTING OPENINGS IN STONE WALL. GENERAL CONTRACTOR TO FIELD VERIFY ALL ROUGH OPENING SIZES AND COORDINATE WITH WINDOW MANUFACTURER. ACCOUNT FOR MOOD BLOCKING AND SHIMS.
- EXTERIOR VIEW OF WINDOW IS SHOWN, TYPICAL.
- IN = DUAL GLAZED, INSULATED GLASS, WITH LOW-E COATING (CARDINAL 212) ON SURFACE #2. INCLUDE LEAD GLASS OVERLAY ON THE EXTERIOR AND INTERIOR PANE. SPACER BARS TO BE ALUMINUM BLACK FINISH, TYPICAL.
- T = 1/4" TEMPERED GLASS.
- SEE LEGEND ON DOOR SCHEDULE ON SHEET 10.10 FOR ADDITIONAL GLAZING TYPES.
- V.I.F. = VERIFY IN FIELD.

WINDOW ELEVATIONS
SCALE: 1/4" = 1'-0"

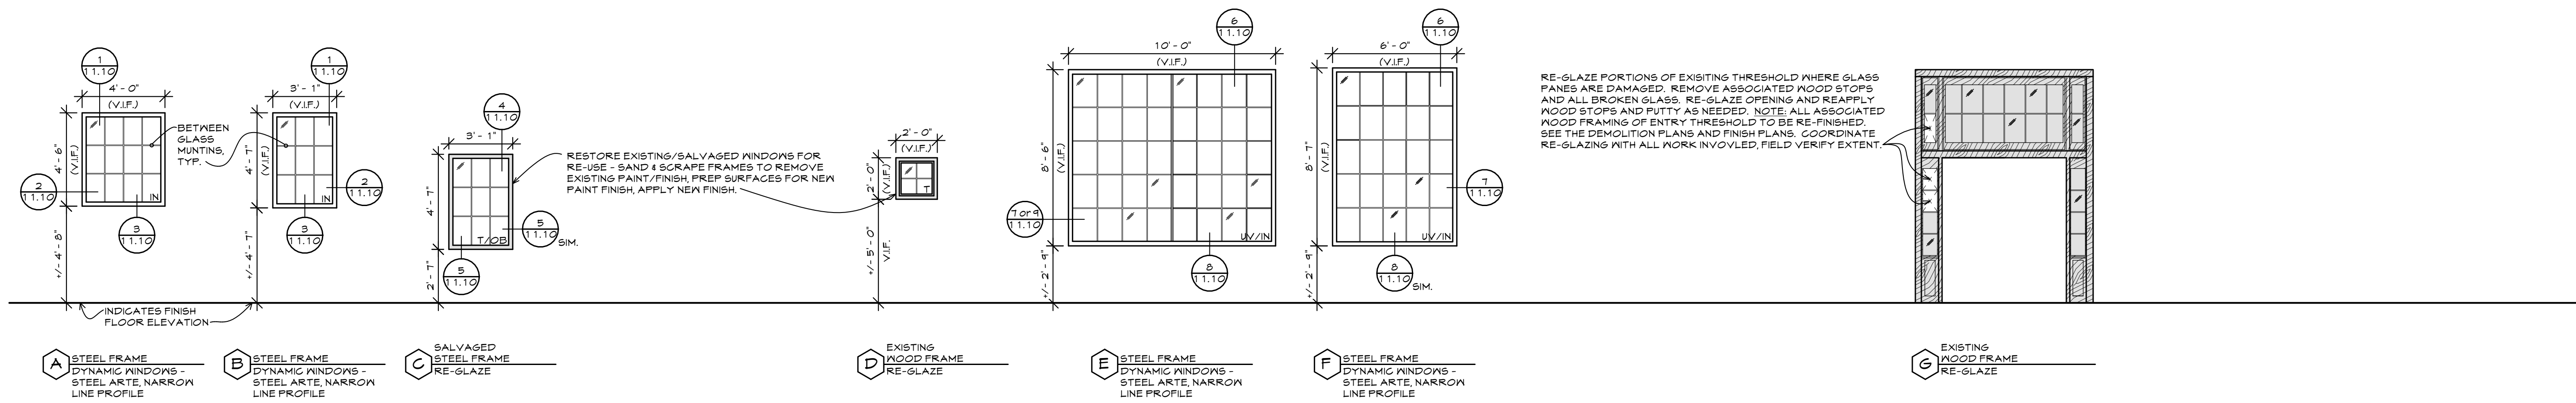





- A STEEL FRAME DYNAMIC WINDOWS - STEEL ARTE, NARROW LINE PROFILE
- B STEEL FRAME DYNAMIC WINDOWS - STEEL ARTE, NARROW LINE PROFILE
- C SALVAGED STEEL FRAME RE-GLAZE
- D EXISTING WOOD FRAME RE-GLAZE
- E STEEL FRAME DYNAMIC WINDOWS - STEEL ARTE, NARROW LINE PROFILE
- F STEEL FRAME DYNAMIC WINDOWS - STEEL ARTE, NARROW LINE PROFILE
- G EXISTING WOOD FRAME RE-GLAZE

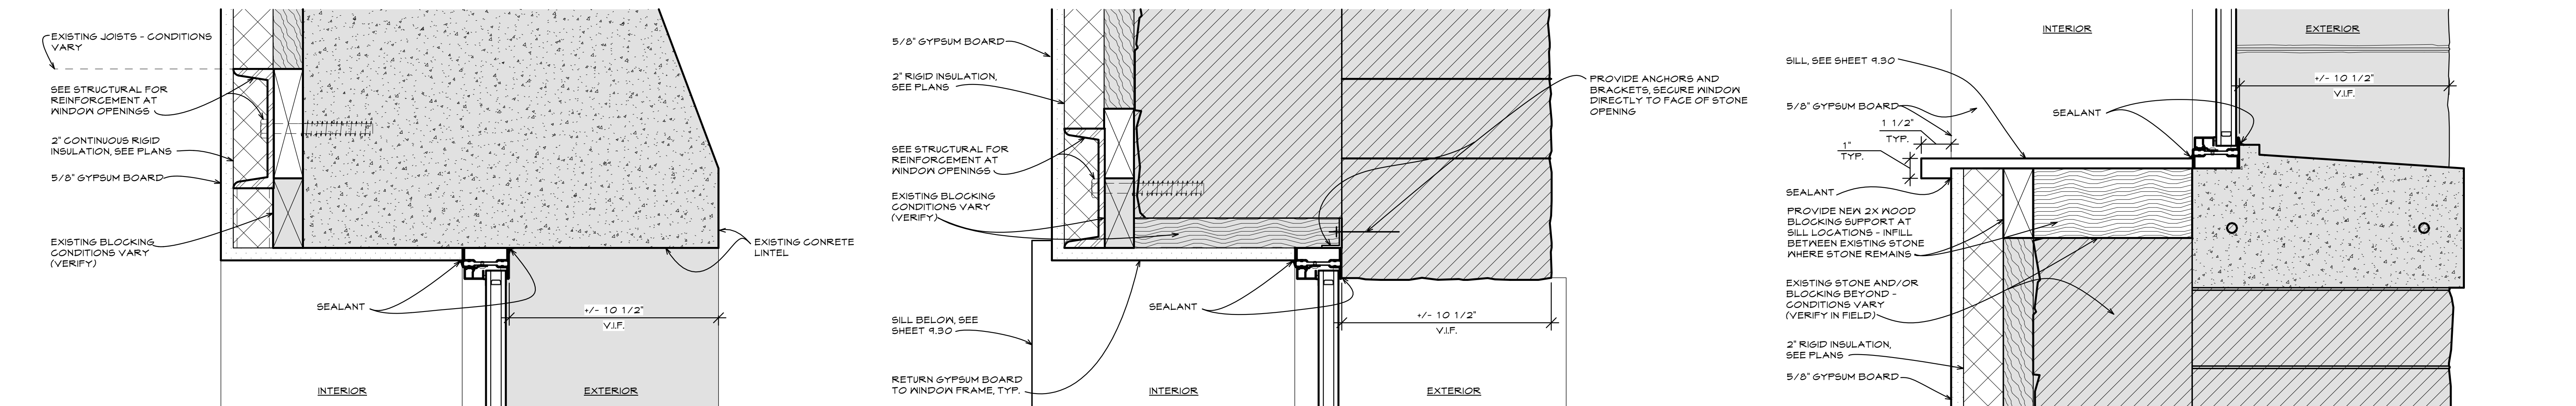

1 STEEL HEAD
SCALE 3" = 1'-0"

2 STEEL JAMB
SCALE 3" = 1'-0"

3 STEEL SILL
SCALE 3" = 1'-0"

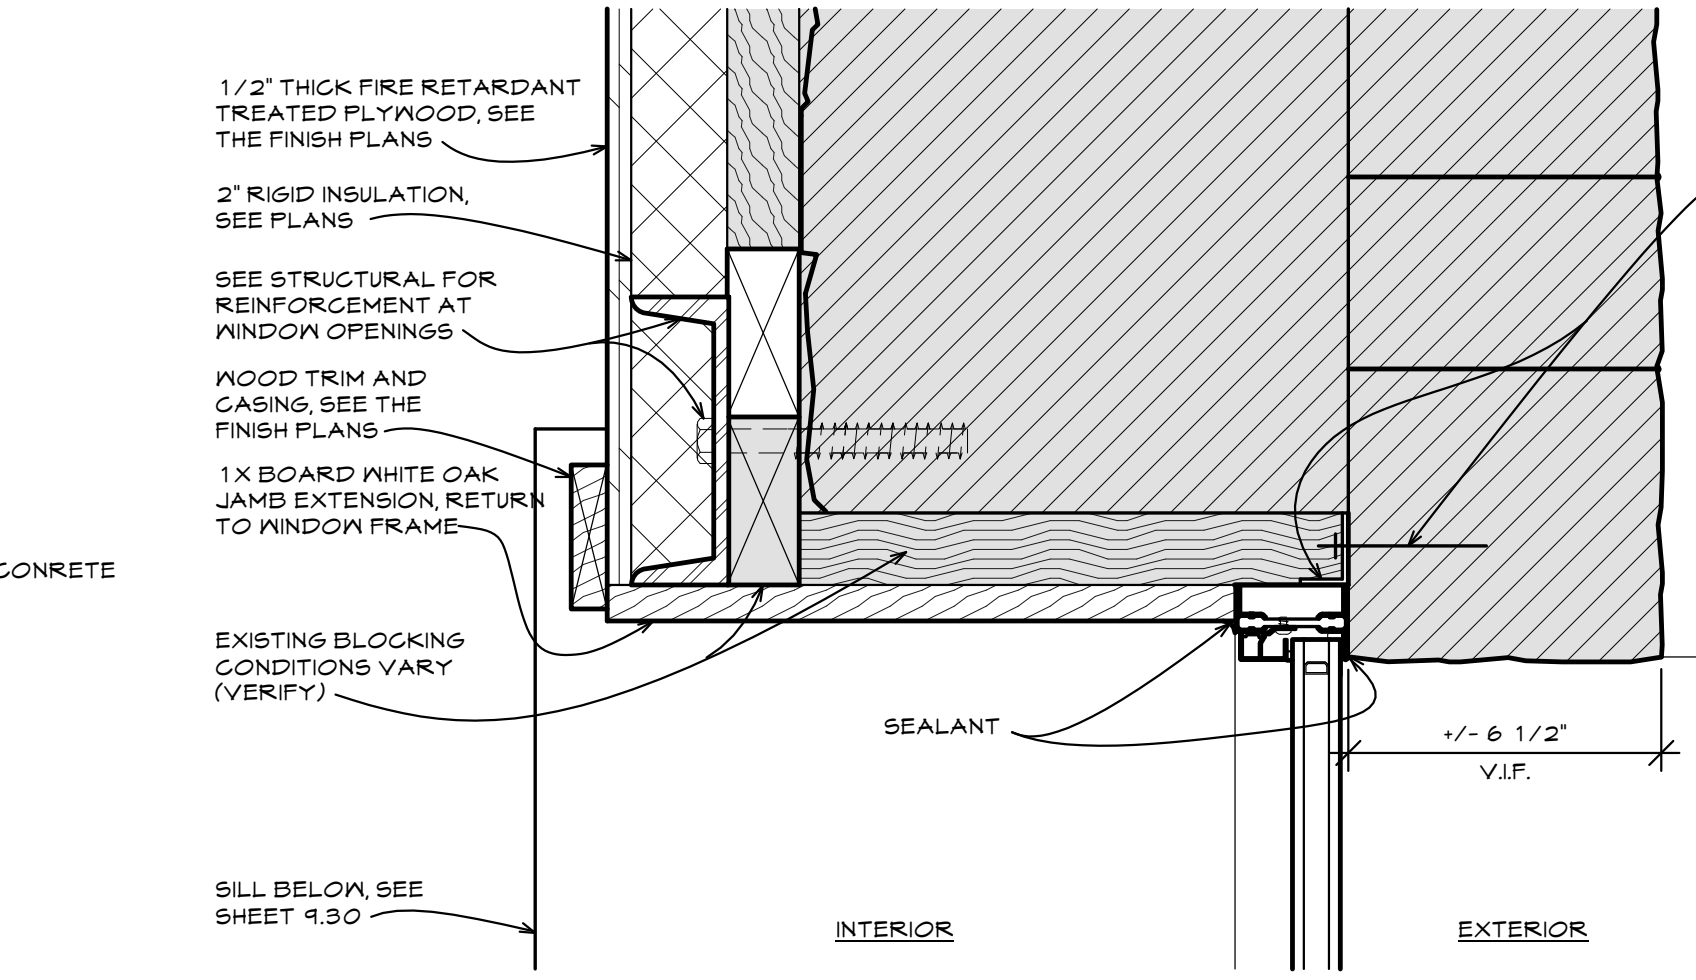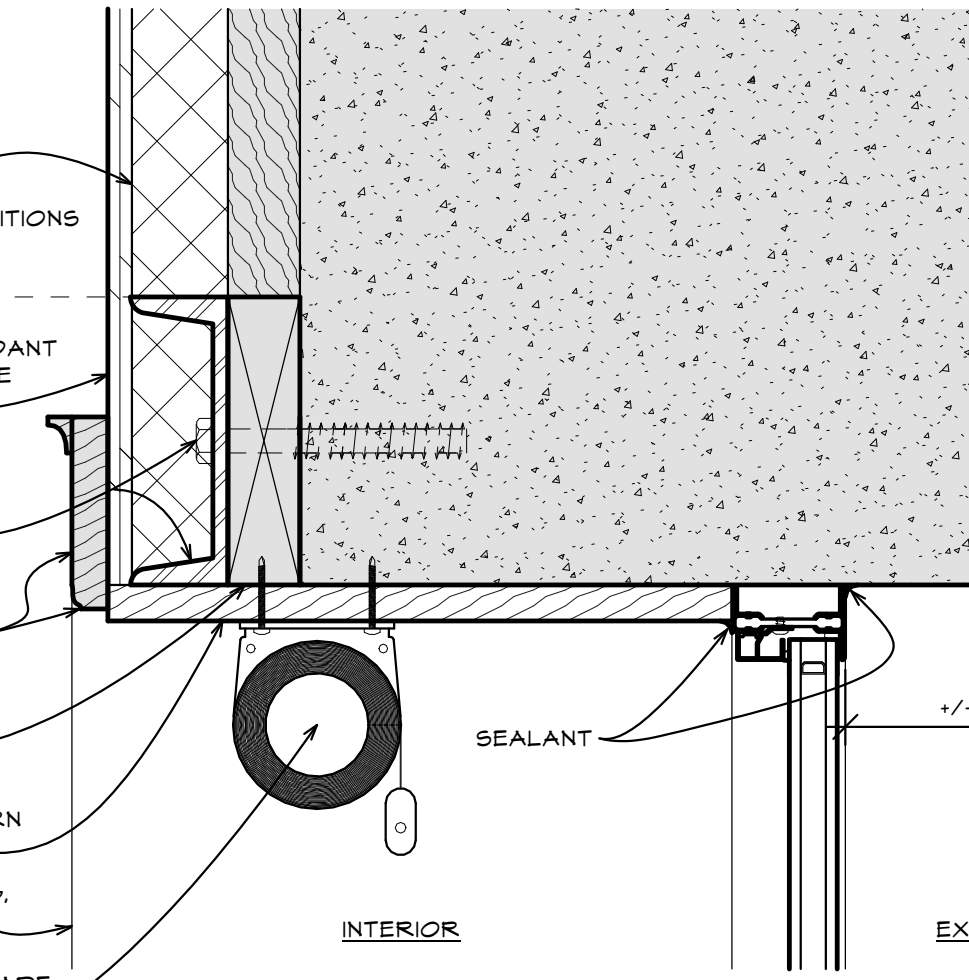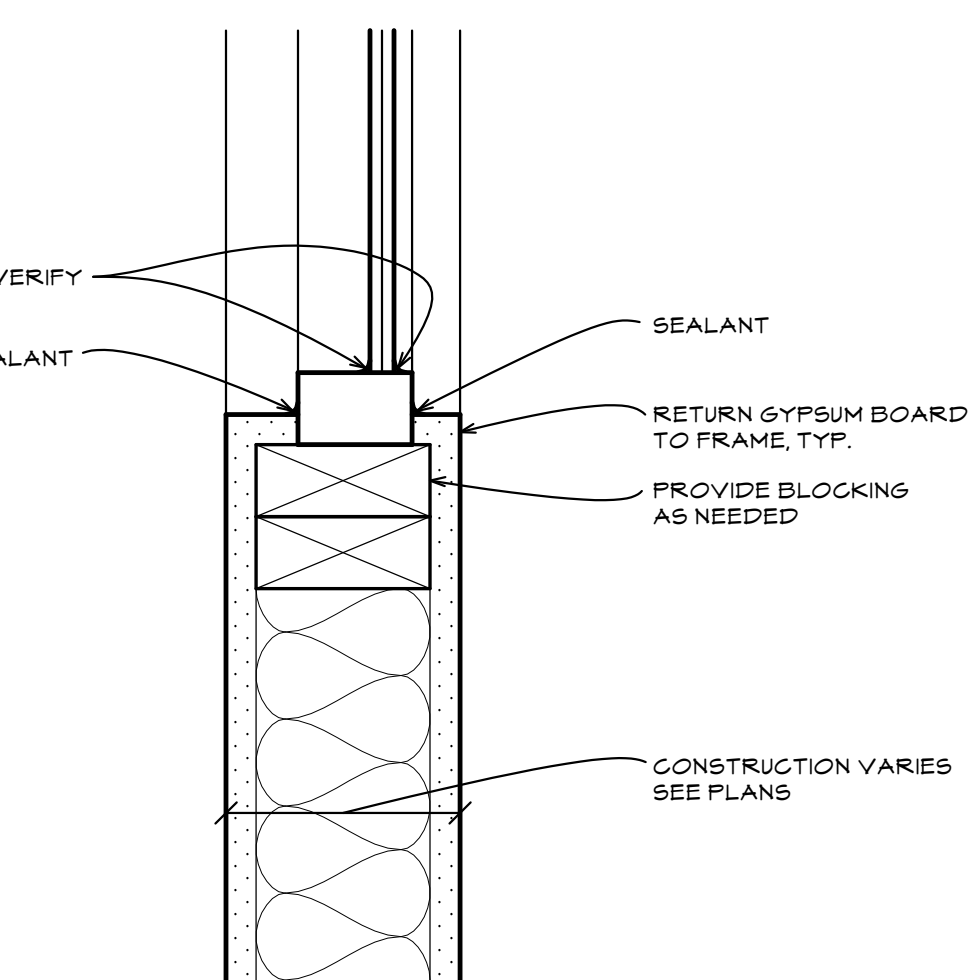
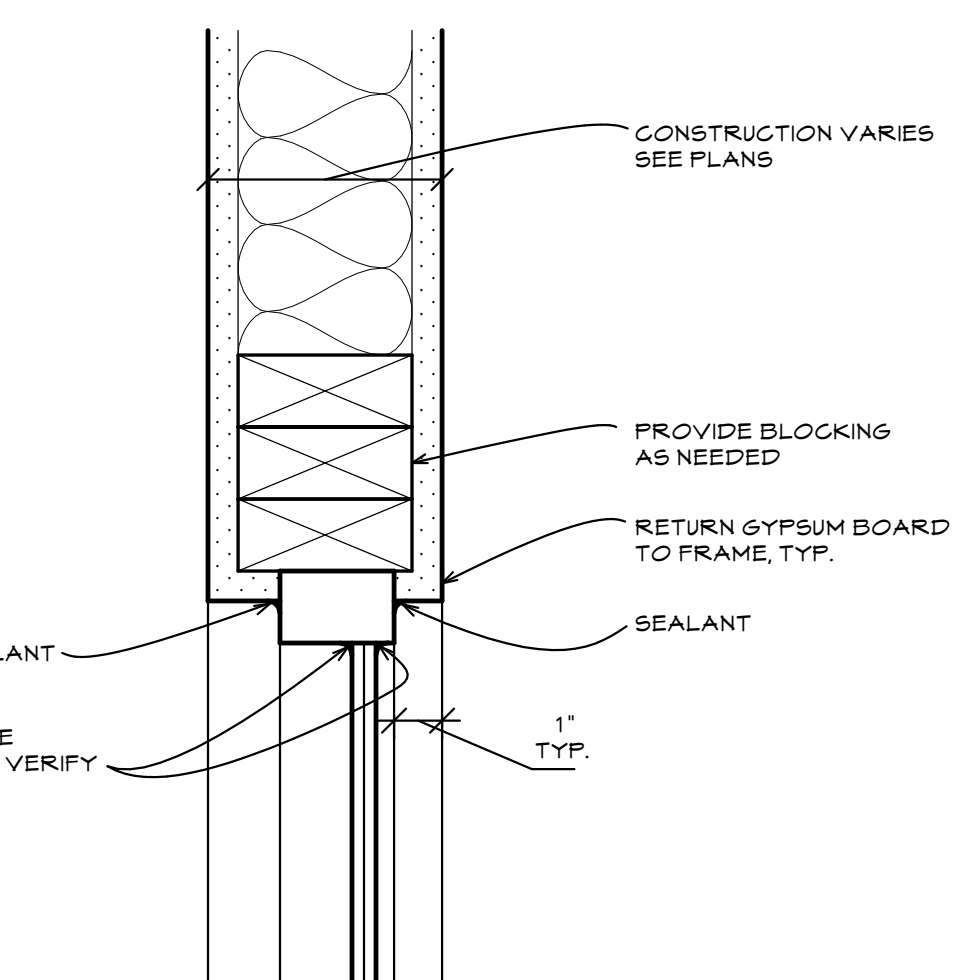


4 STEEL HEAD
SCALE 3" = 1'-0" (JAMB IS SIMILAR)

5 STEEL SILL
SCALE 3" = 1'-0" (JAMB IS SIMILAR)

6 STEEL HEAD
SCALE 3" = 1'-0"

7 STEEL JAMB
SCALE 3" = 1'-0"

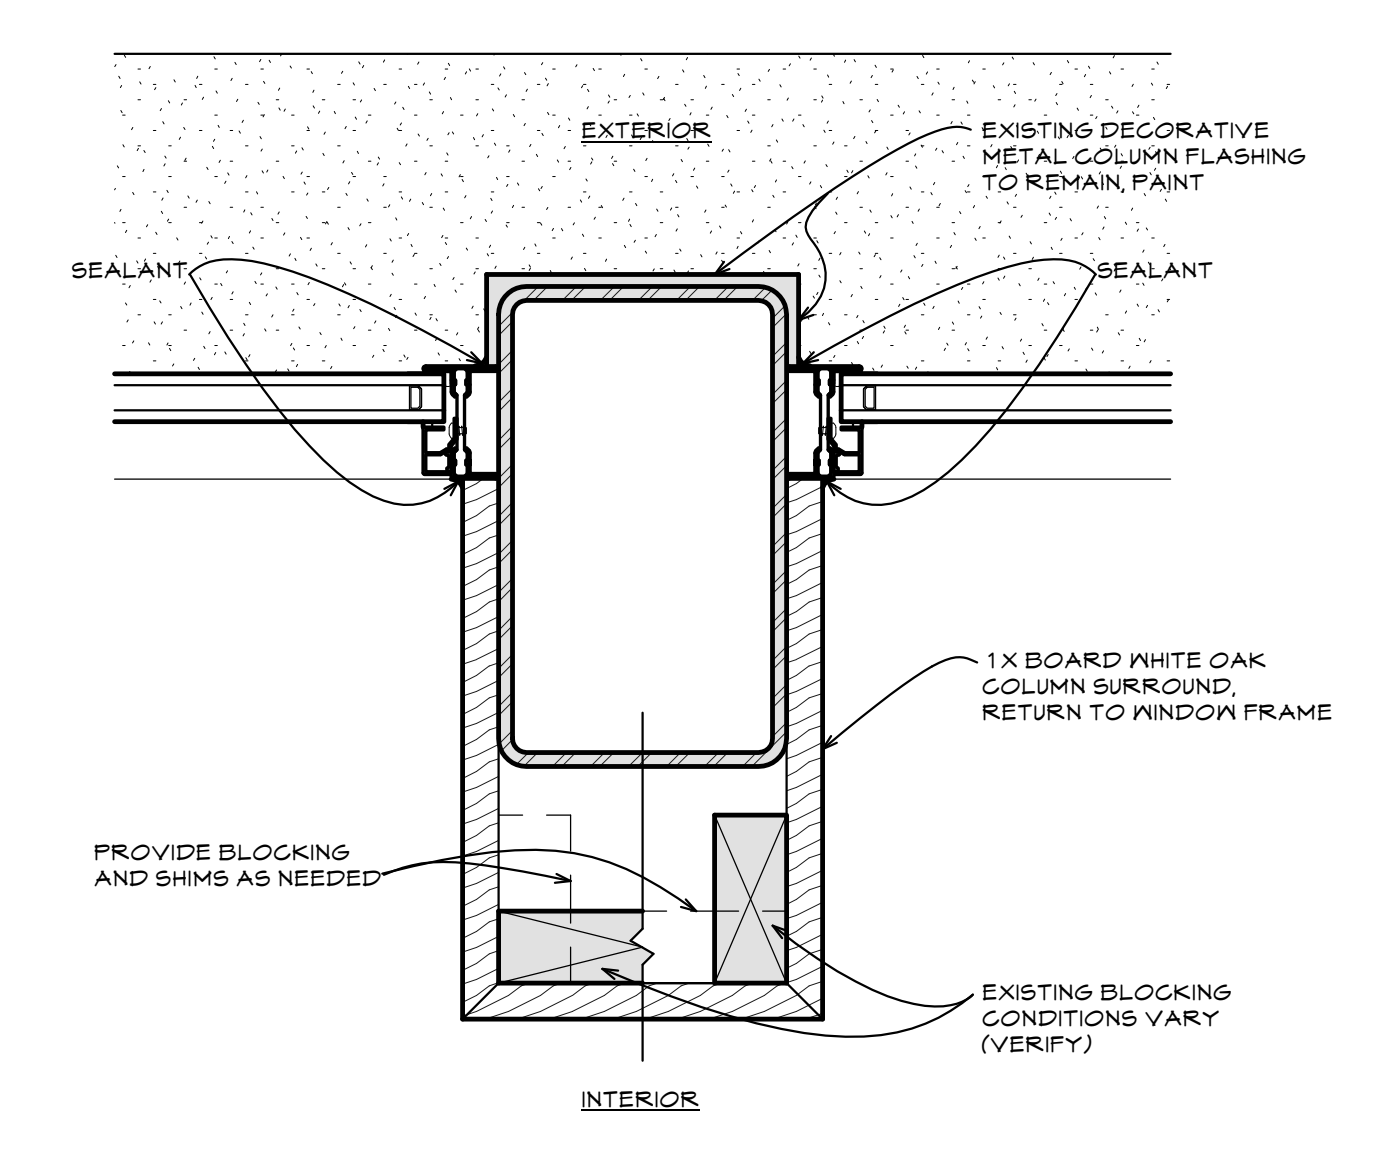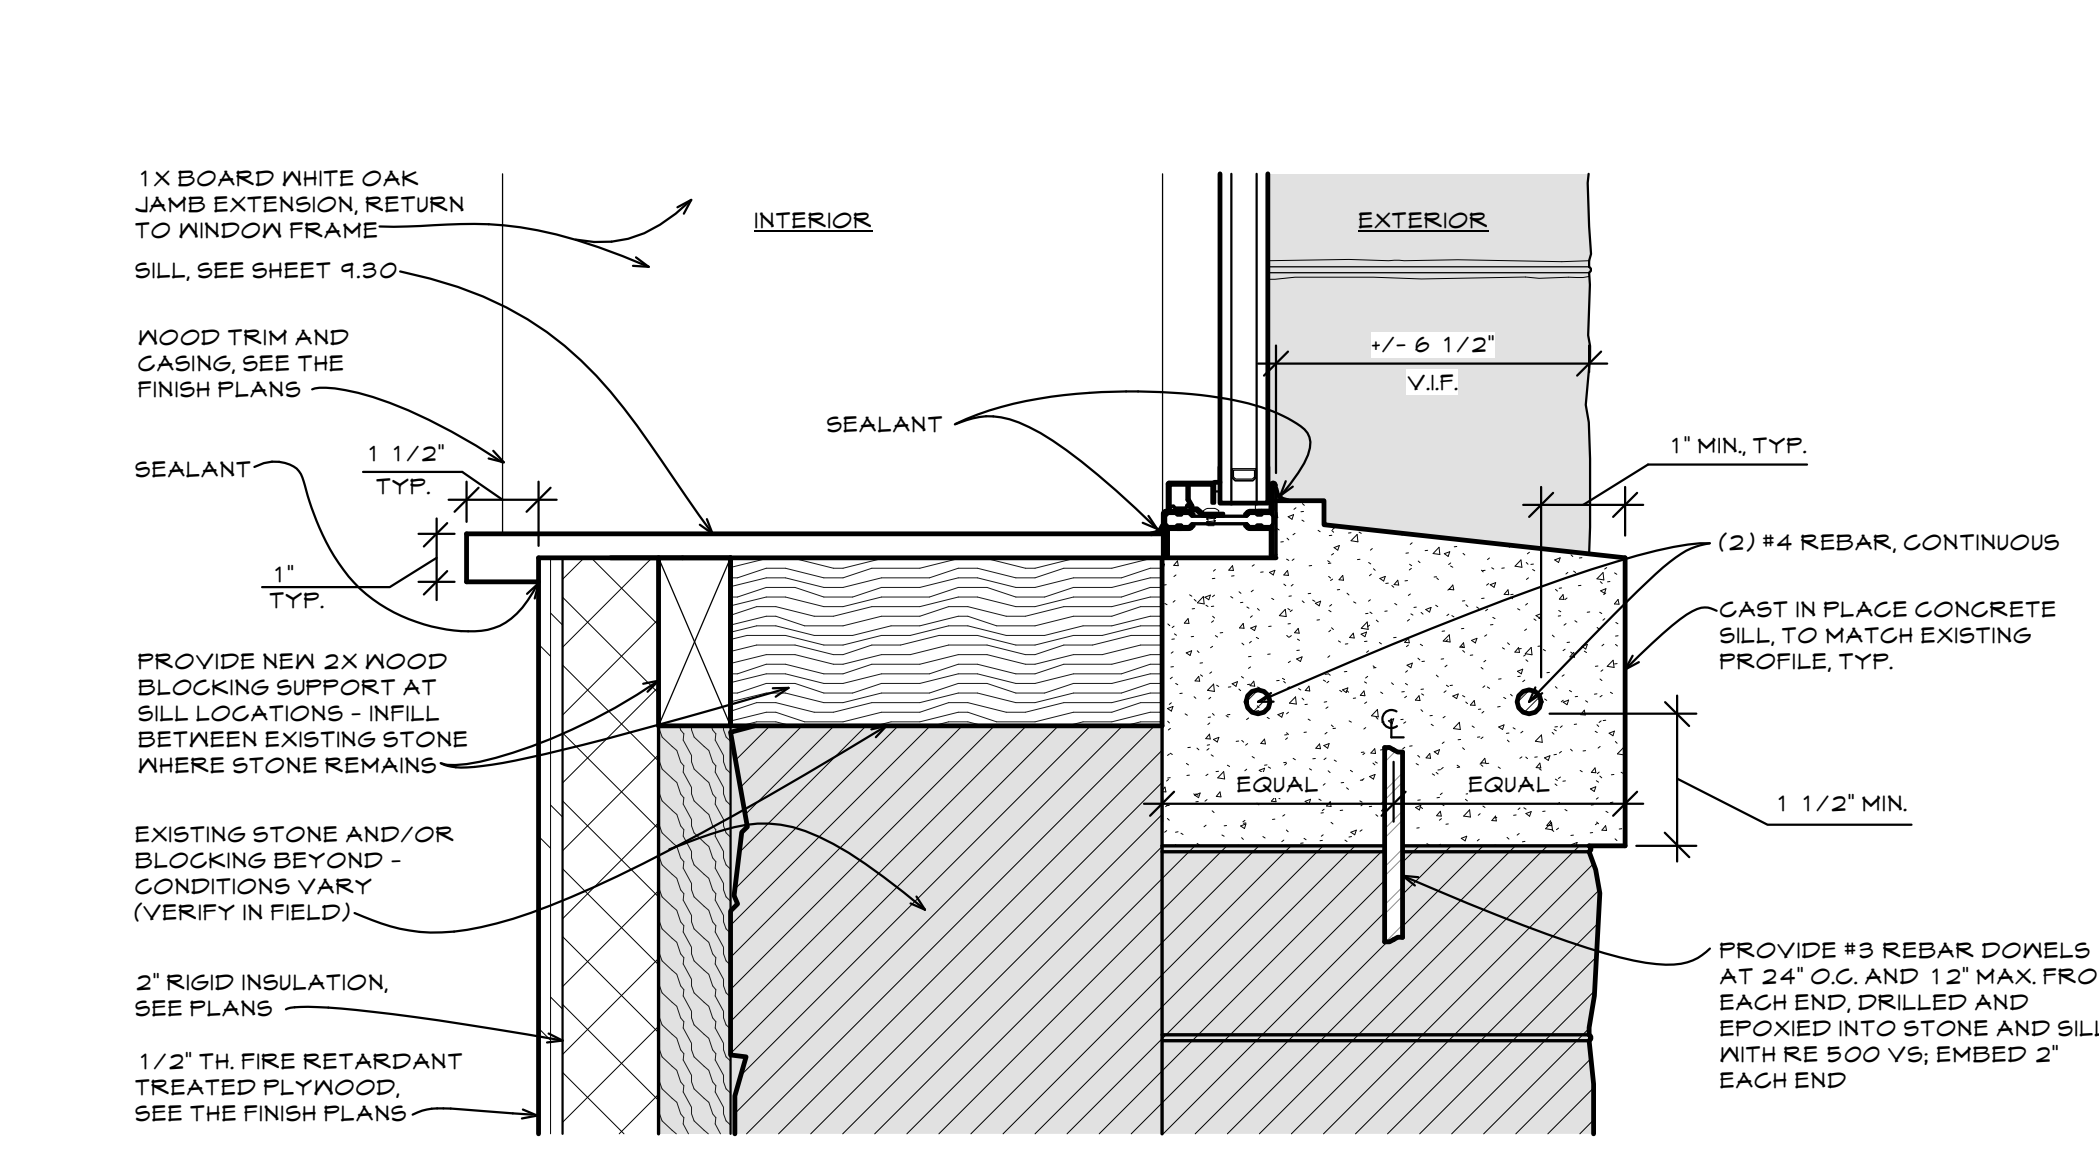

8 STEEL SILL
SCALE 3" = 1'-0"

9 STEEL JAMB
SCALE 3" = 1'-0"

OLD STONEY REMODEL
PHASE ONE
108 NORTH 4TH STREET
SUNDANCE, WYOMING 82729



PROJECT NUMBER
16-022

DATE
11-20-2017

DRAWN BY
KFOX

DISK ID.
16-022 Old Stoney/16-022_Old Stoney.rvt

SHEET TITLE
WINDOW ELEVATIONS & DETAILS

SHEET NUMBER
11.10