

GENERAL NOTES


- GENERAL NOTES, KEYNOTES, AND LEGEND ON THIS SHEET REFER TO THIS SHEET ONLY.
- SEE CIVIL, STRUCTURAL, MECHANICAL, AND ELECTRICAL PLANS FOR ADDITIONAL INFORMATION.
- ALL DOOR AND OR WINDOW SIZES SHOWN ARE NOMINAL. CONTRACTOR TO VERIFY ROUGH OPENING SIZES IN FIELD AND WITH DOOR & WINDOW MANUFACTURER.
- SEE DOOR AND WINDOW SHEETS FOR INFORMATION ON DOORS AND WINDOWS NUMBERED/LABELLED ON THIS SHEET.

KEYNOTES

- MECHANICAL SHAFT OPENINGS. SEE THE DIMENSION PLANS, REFLECTED CEILING PLANS & DETAILS, MECHANICAL DRAWINGS, AND STRUCTURAL DRAWINGS FOR ADDITIONAL INFORMATION.
- PROVIDE INFILL FLOORING WHERE EXISTING SLAB HAS DEMOD FOR STAIR CONSTRUCTION. SEE THE STRUCTURAL DRAWINGS FOR DETAILS AND THE FINISH PLANS.
- PROVIDE INFILL FLOORING WHERE EXISTING FLOOR WAS DEMOD FOR STAIR CONSTRUCTION. SEE THE STRUCTURAL DRAWINGS FOR DETAILS AND THE FINISH PLANS.
- RIGID INSULATION APPLIED TO FACE OF EXISTING WOOD STUD FURRING OR PLASTER - ENTIRE LENGTH OF EXTERIOR WALL, TYP. SEE THE DIMENSION PLAN FOR ADDITIONAL INFORMATION.
- NOT USED.
- NOT USED.
- NOT USED.
- NOT USED.
- ELEVATOR SHAFT. SEE STRUCTURAL FOR CONSTRUCTION. SEE THE DIMENSION PLAN AND SHEET 8.30 FOR ADDITIONAL INFORMATION.
- NOT USED.
- WALK OFF MATT AT ENTRY. SEE THE FINISH PLANS FOR ADDITIONAL INFORMATION.
- PROVIDE WOOD FILLER AND RE-FINISH ENDS OF EXISTING DOOR JAMBS WHERE DOORS HAVE BEEN REMOVED - SEE THE FINISH PLANS.
- SALVAGE EXISTING RADIATORS FOR RE-USE. COORDINATE NEW LOCATION WITH OWNER.
- LOCATE RESTROOM SIGNAGE IN THIS LOCATION. COORDINATE ROOM NAMES WITH PLAN. SEE THE SIGNAGE LEGEND ON SHEET 4.30.
- LOCATE ELEVATOR FLOOR LEVEL SIGNAGE IN THIS LOCATION. SEE THE SIGNAGE LEGEND ON SHEET 4.30.
- LOCATE DIRECTIONAL STAIR EXIT SIGNAGE IN THIS LOCATION. SEE THE SIGNAGE LEGEND ON SHEET 4.30.
- CAST-IN-PLACE CONCRETE WINDOW SILL TO MATCH PROFILE OF EXISTING. FIELD VERIFY. SEE 8.7/1.10 FOR TYPICAL CONSTRUCTION. REMOVE AND REPLACE EXISTING WINDOW AS NECESSARY FOR INSTALLATION.
- RECESSED CABINET HEATER. SEE THE MECHANICAL DRAWINGS.
- BUILDING PLAQUE. SEE 10/4.30.
- INSTALL SURFACE MOUNTED KNOX BOX. CONFIRM LOCATION WITH FIRE DEPARTMENT.
- PROVIDE STEEL PIPE COLUMN AT WALL END FOR STABILITY. SEE 4/8.20.
- PROVIDE INFILL FLOORING WHERE EXISTING SLAB HAS DEMOD FOR UNDERGROUND DUCTWORK. SEE THE MECHANICAL DRAWINGS, STRUCTURAL DRAWINGS, AND THE FINISH PLANS.



LEGEND

- EXISTING ITEMS - TO REMAIN UNLESS NOTED OTHERWISE
- NEW CONCRETE - SEE THE STRUCTURAL DRAWINGS FOR THICKNESS AND CONSTRUCTION
- NEW FIRE RATED SHAFT WALLS - SEE THE DIMENSION PLAN FOR TYPICAL CONSTRUCTION
- NEW WOOD STUD WALLS - SEE THE DIMENSION PLAN FOR TYPICAL CONSTRUCTION
- 2" OF CONTINUOUS RIGID INSULATION APPLIED TO FACE OF EXISTING 2 X 4 WOOD FURRING - POLYISOCYANURATE BOARD, R - VALUE OF 10 MINIMUM
- 1 1/2" WOOD STUD FURRING APPLIED TO FACE OF EXISTING PLASTER WITH 2" CONTINUOUS RIGID INSULATION FACING - POLYISOCYANURATE BOARD, R - VALUE OF 10 MINIMUM
- NEW STEEL BAR-GRATING: PLAN STEEL PRESS LOCKED BAR GRATING WITH 1 1/2" DEEP BEARING BARS, 3/16" THICK SPACED 7/16" O.C. CROSS BARS AT 4" O.C. FINISH TO BE POWDER COATED. COLOR TO BE SELECTED
- EARTH/UNEXCAVATED AREAS
- F.E.C. DENOTES FIRE EXTINGUISHER AND CABINET. SEE THE ACCESSORIES LEGEND ON SHEET 4.30

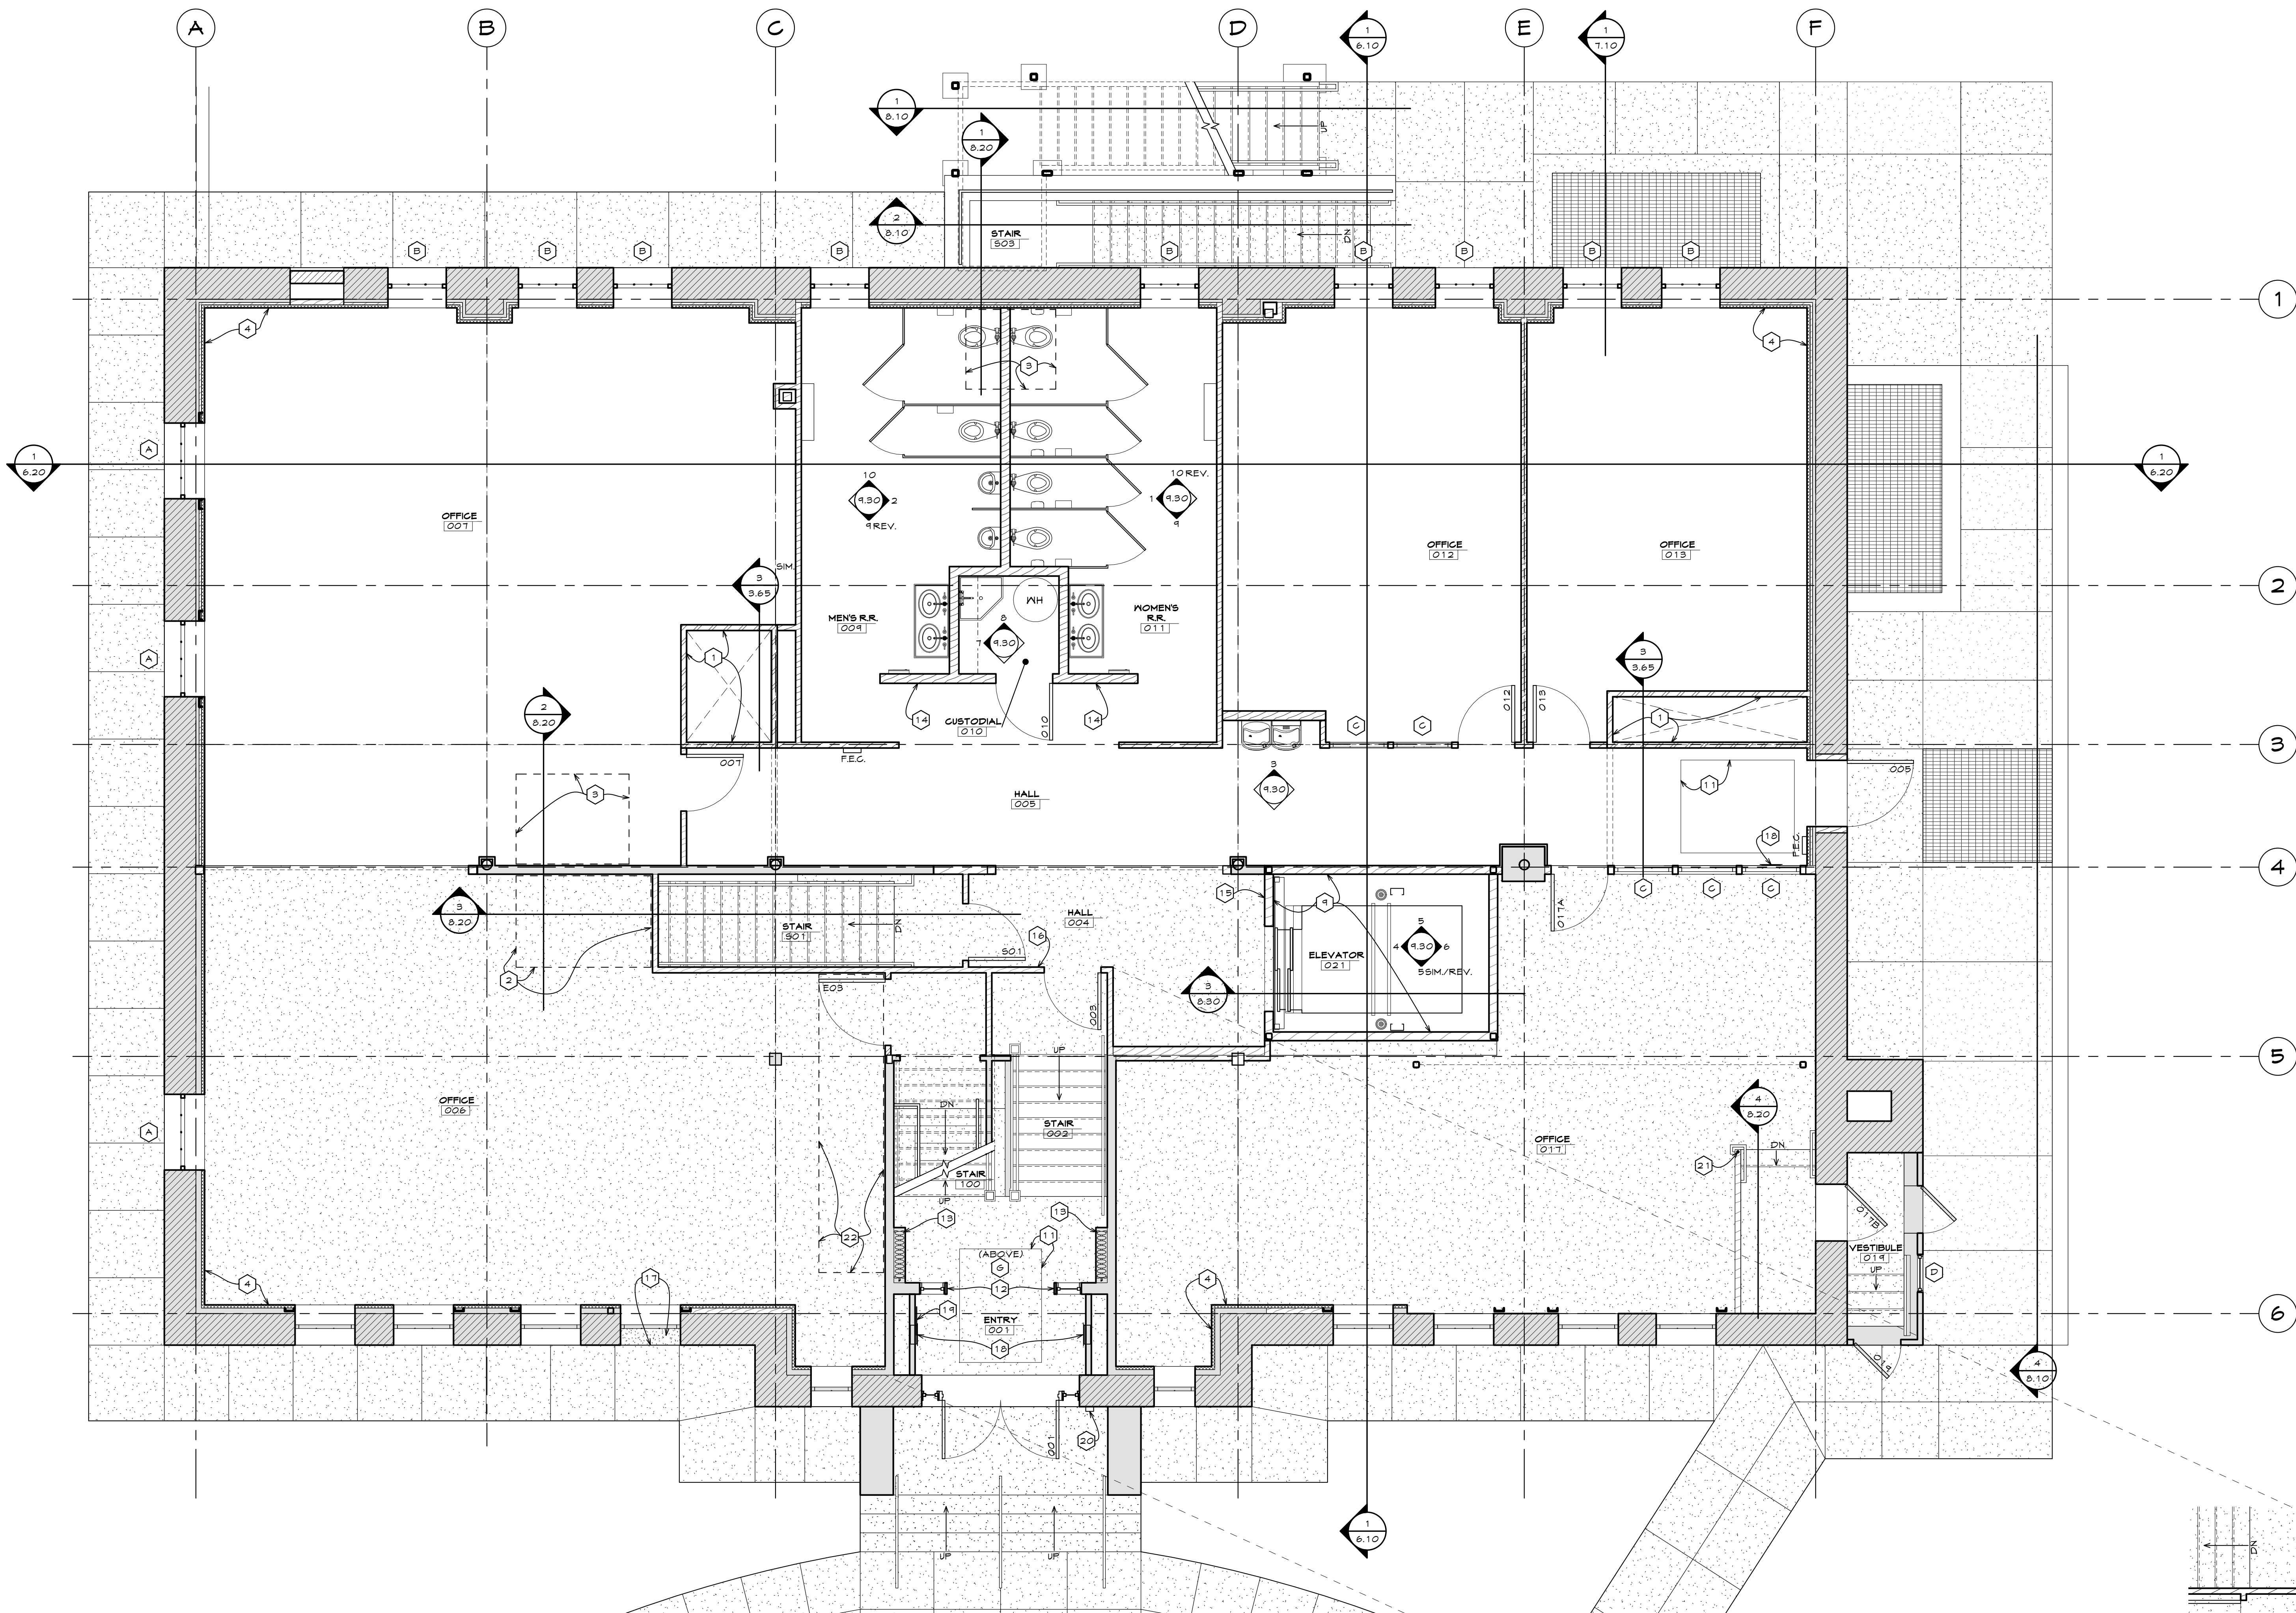

BASEMENT REFERENCE PLAN

SCALE: 1/4" = 1'-0"

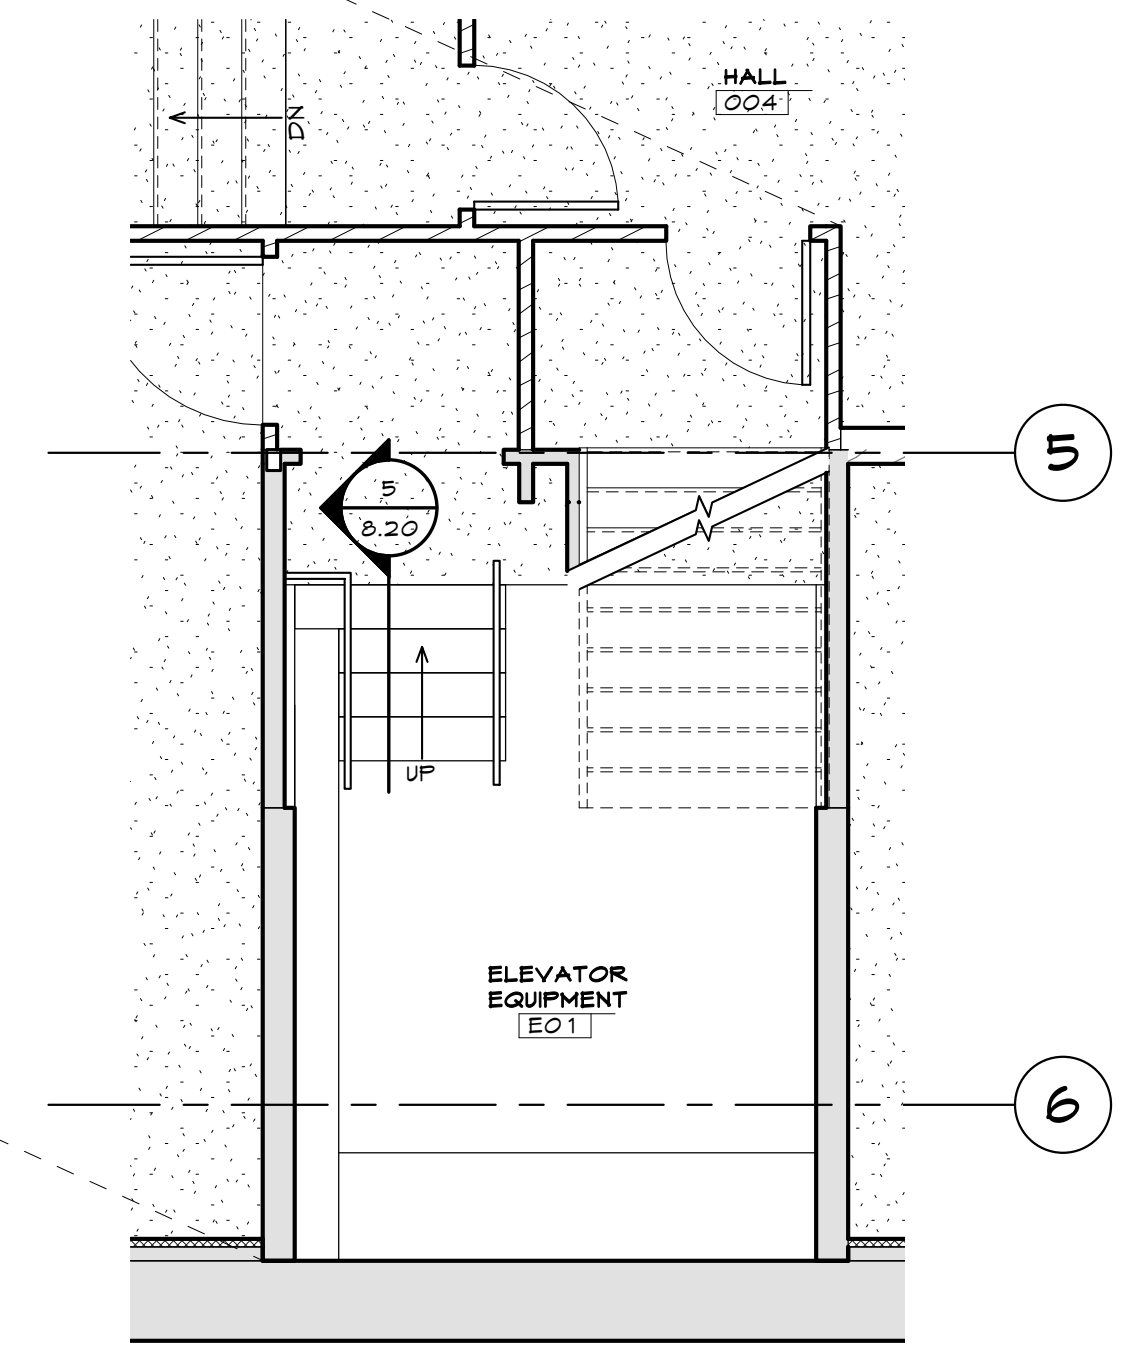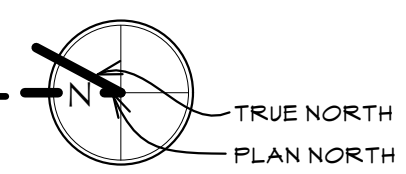

ELEVATOR EQUIPMENT ROOM REFERENCE PLAN

SCALE: 1/4" = 1'-0"

OLD STONEY REMODEL
 PHASE ONE
 108 NORTH 4TH STREET
 SUNDANCE, WYOMING 82729

Staline No. 7
 ARCHITECTS

PROJECT NUMBER
 16-022

DATE
 11-20-2017

DRAWN BY
 KFOX
 A WILLIAMSON

DISK ID.
 16-022 Old
 Stoney/16-022_Old
 Stoney.rvt

SHEET TITLE
 BASEMENT
 REFERENCE PLAN

SHEET NUMBER

3.45