

LEGEND


- EXISTING ITEMS - TO REMAIN UNLESS NOTED OTHERWISE.
- EXISTING CMU BLOCK INFILL TO RECEIVE PAINT, COLOR TO BE SELECTED
- NEW CMU BLOCK INFILL, PAINT, COLOR TO BE SELECTED
- ORIGINAL SANDSTONE
- CONCRETE SILLS, LINTELS, AND WATER TABLE
- ASPHALT SHINGLES MATCH TO EXISTING
- WOOD SIDING, PAINT COLOR TO BE SELECTED

GENERAL NOTES


1. GENERAL NOTES, KEYNOTES, AND LEGEND ON THIS SHEET REFER TO THIS SHEET ONLY.
2. SEE MECHANICAL, ELECTRICAL, STRUCTURAL AND CIVIL DRAWINGS FOR ADDITIONAL INFORMATION.
3. ALL GUTTERS AND DOWNSPOUTS TO BE PREFINISHED.
4. SEE SHEET 1.0, 1.0 AND 1.1, 1.0 FOR DOOR AND WINDOW INFORMATION AND FINISHES.
5. METAL FLASHING TO BE SELECTED FROM THE MANUFACTURER'S STANDARD RANGE OF COLORS TO MATCH FINISHES (SEE SHEET 1.1, 1.0).
6. PROVIDE AND INSTALL KNOX BOX 36" A.F.F. FLUSH MOUNT TO STONE. COORDINATE EXACT LOCATION WITH FIRE DEPARTMENT.
7. SURROUNDING BUILDINGS NOT SHOWN FOR CLARITY, SEE THE SITE PLAN AND CIVIL DRAWINGS.

KEYNOTES


- 1 ELECTRICAL SERVICES, PAINT.
- 2 FOUNDATION, SEE STRUCTURAL DRAWINGS.
- 3 NOT USED.
- 4 PREFINISHED 6" X 4 1/2" RECTANGULAR GUTTER, SEE SPEC.
- 5 PREFINISHED 4 1/2" X 4 1/2" SQUARE DOWNSPOUT, SEE SPEC.
- 6 NOT USED.
- 7 DEMO ALL EXISTING SHINGLE LAYERS ON SHED ROOF DOWN TO SUB-ROOFING. INSTALL 1/2" PLYWOOD SHEATHING, 15# BUILDING PAPER, ICE/WATER SHIELD, AND SHINGLES. PROVIDE PREFINISHED METAL DRIP EDGE, COLOR TO BE SELECTED.
- 8 NOT USED.
- 9 PAINT EXISTING CMU BLOCK INFILL, COLOR TO BE SELECTED.
- 10 NOT USED.
- 11 NOT USED.
- 12 NOT USED.
- 13 NOT USED.
- 14 REMOVE EXISTING FIRE ESCAPE AND ALL ASSOCIATED ATTACHMENTS, PLATFORMS, AND ANCHORS TO GRADE. GROUT HOLES IN MASONRY AS NEEDED WHERE FIRE ESCAPE WAS ANCHORED TO BUILDING.
- 15 INFILL WITH CMU AT LOCATION - SEE THE FLOOR PLANS, PAINT.
- 16 NOT USED.
- 17 NOT USED.
- 18 SEAL ROOF PENETRATION WATER TIGHT, SEE SHEET 1.20 AND MECHANICAL DRAWINGS.
- 19 NOT USED.
- 20 NOT USED.
- 21 NOT USED.
- 22 PROVIDE PREFINISHED METAL FLASHING ALONG UPPER EDGES OF SHED ROOF WHERE SHINGLES MEET STONE FACADE. SAWN-GUT STONE AND INSTALL FLASHING INTO STONE. PROVIDE CONTINUOUS SEALANT ALONG ENTIRE LENGTH OF TRIM - SEAL WATER TIGHT.

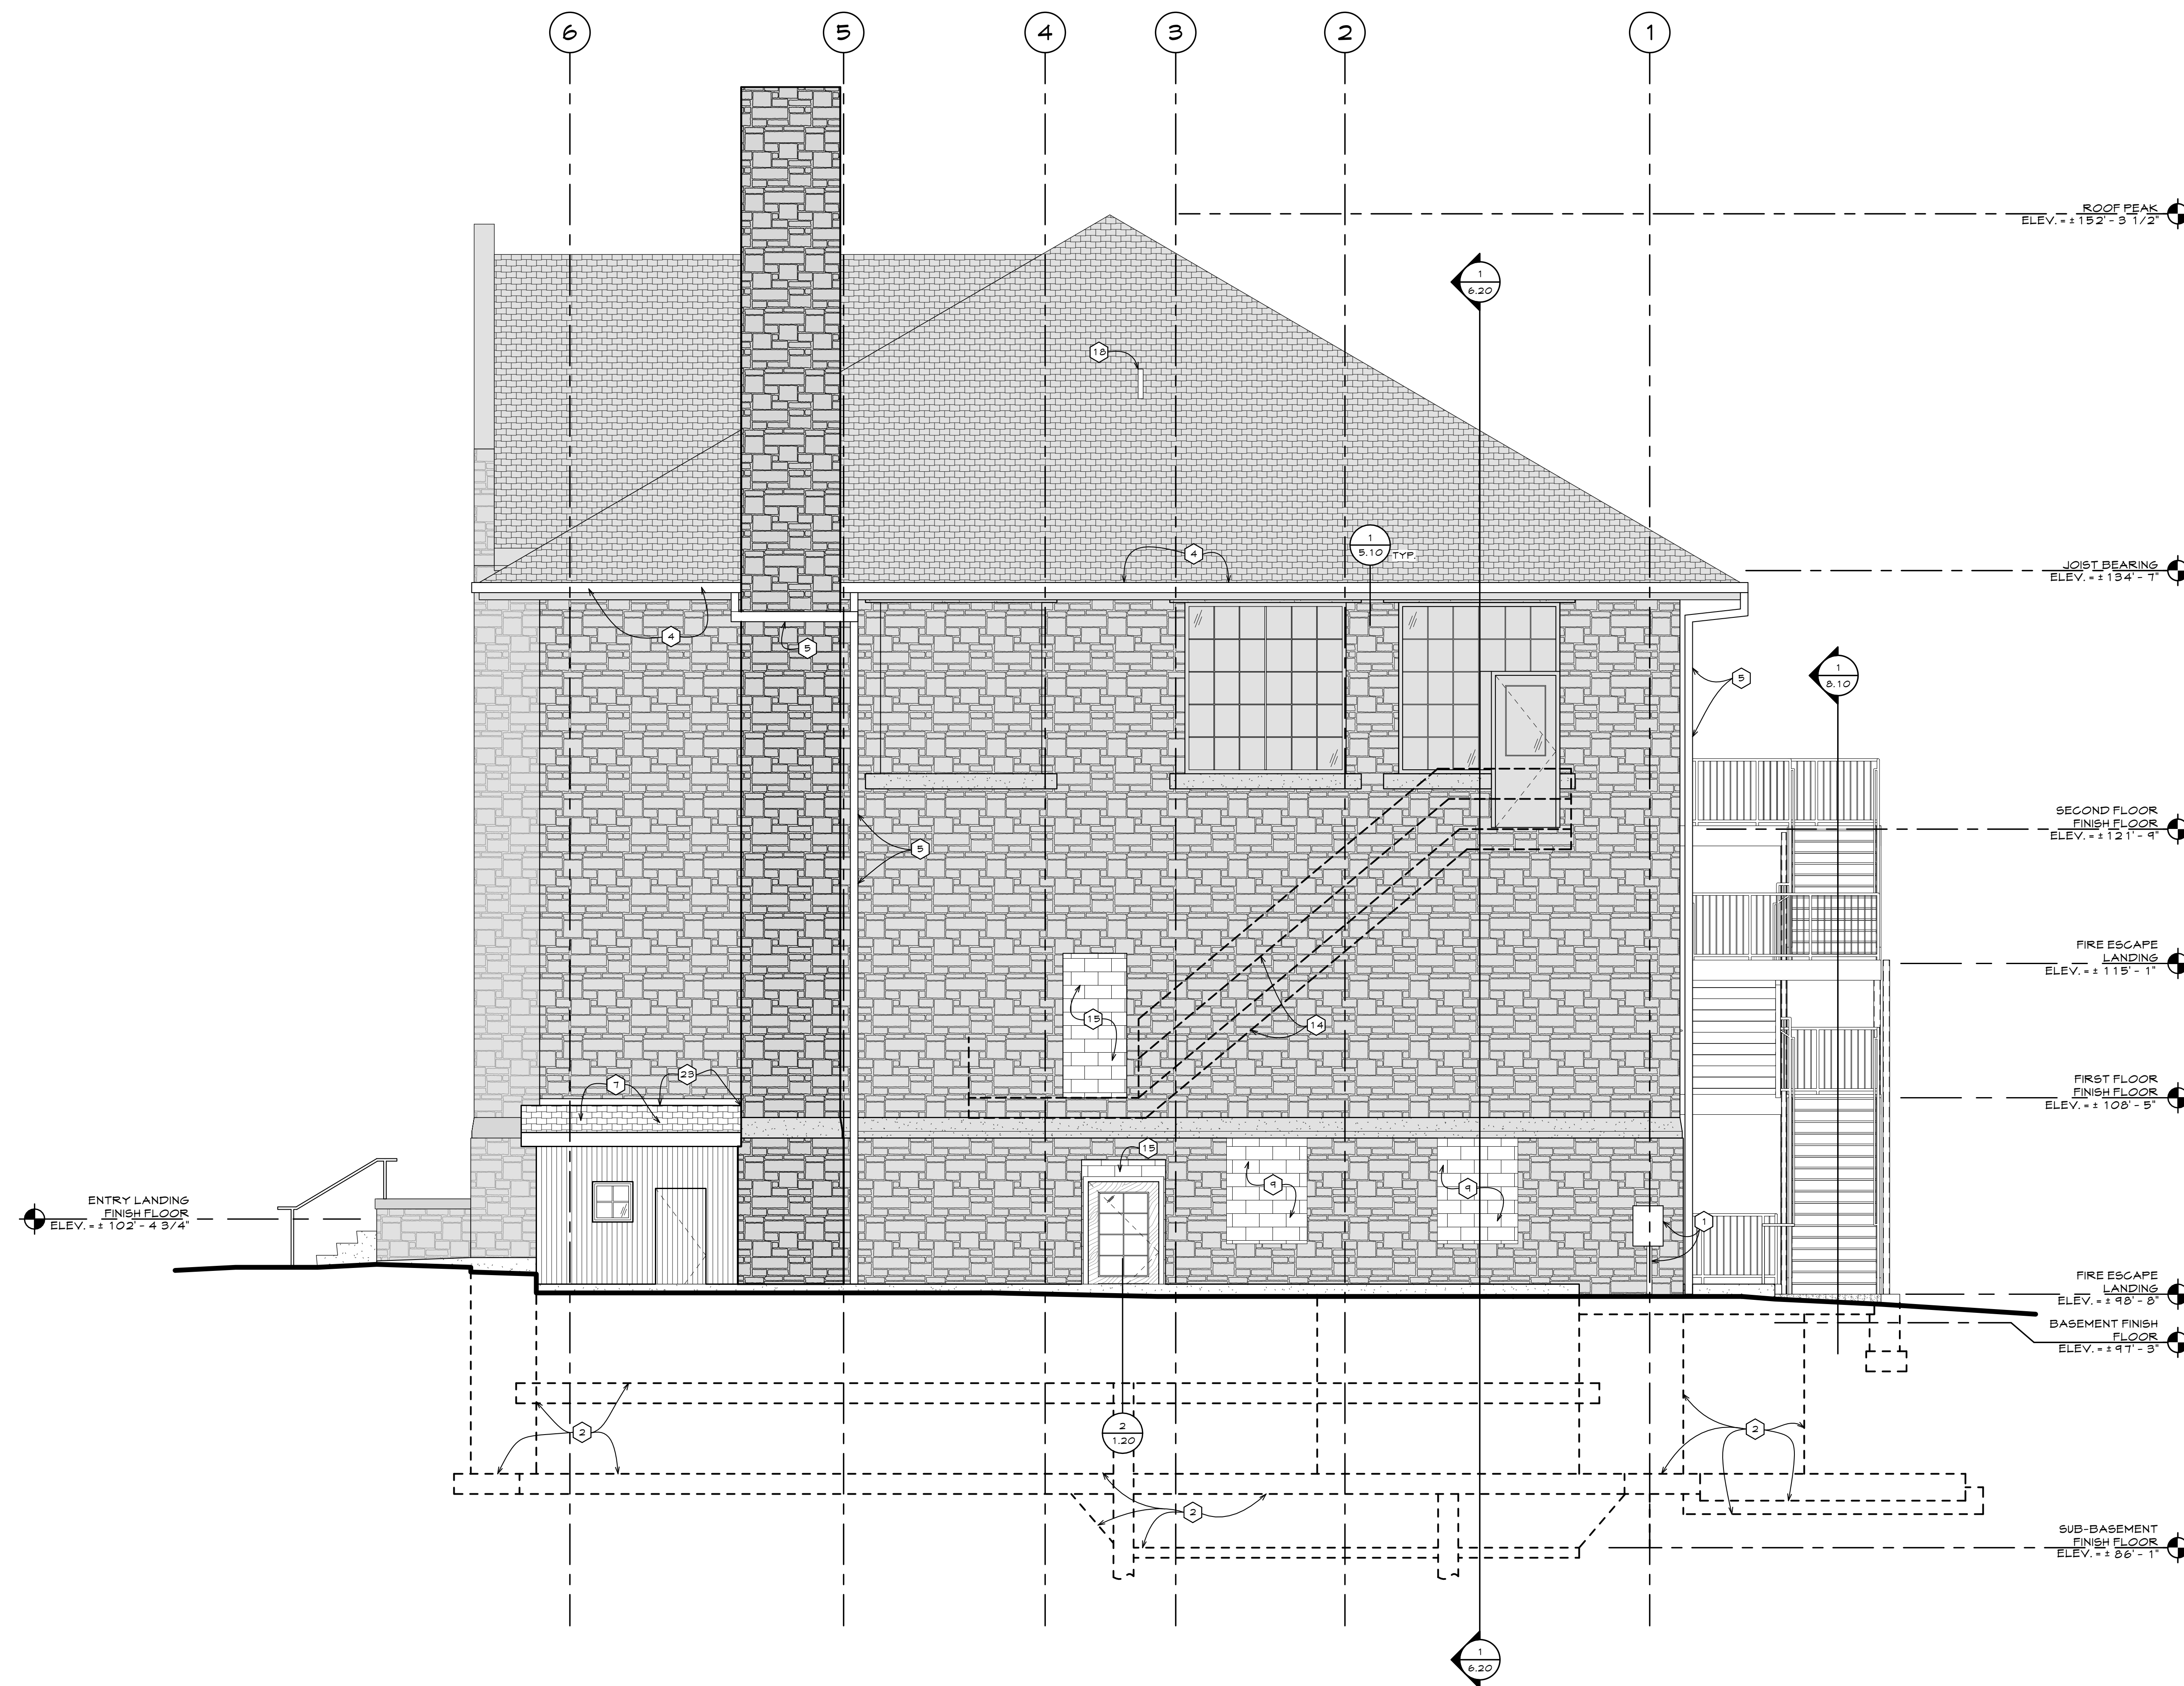

SOUTH ELEVATION
SCALE: 1/4" = 1'-0"

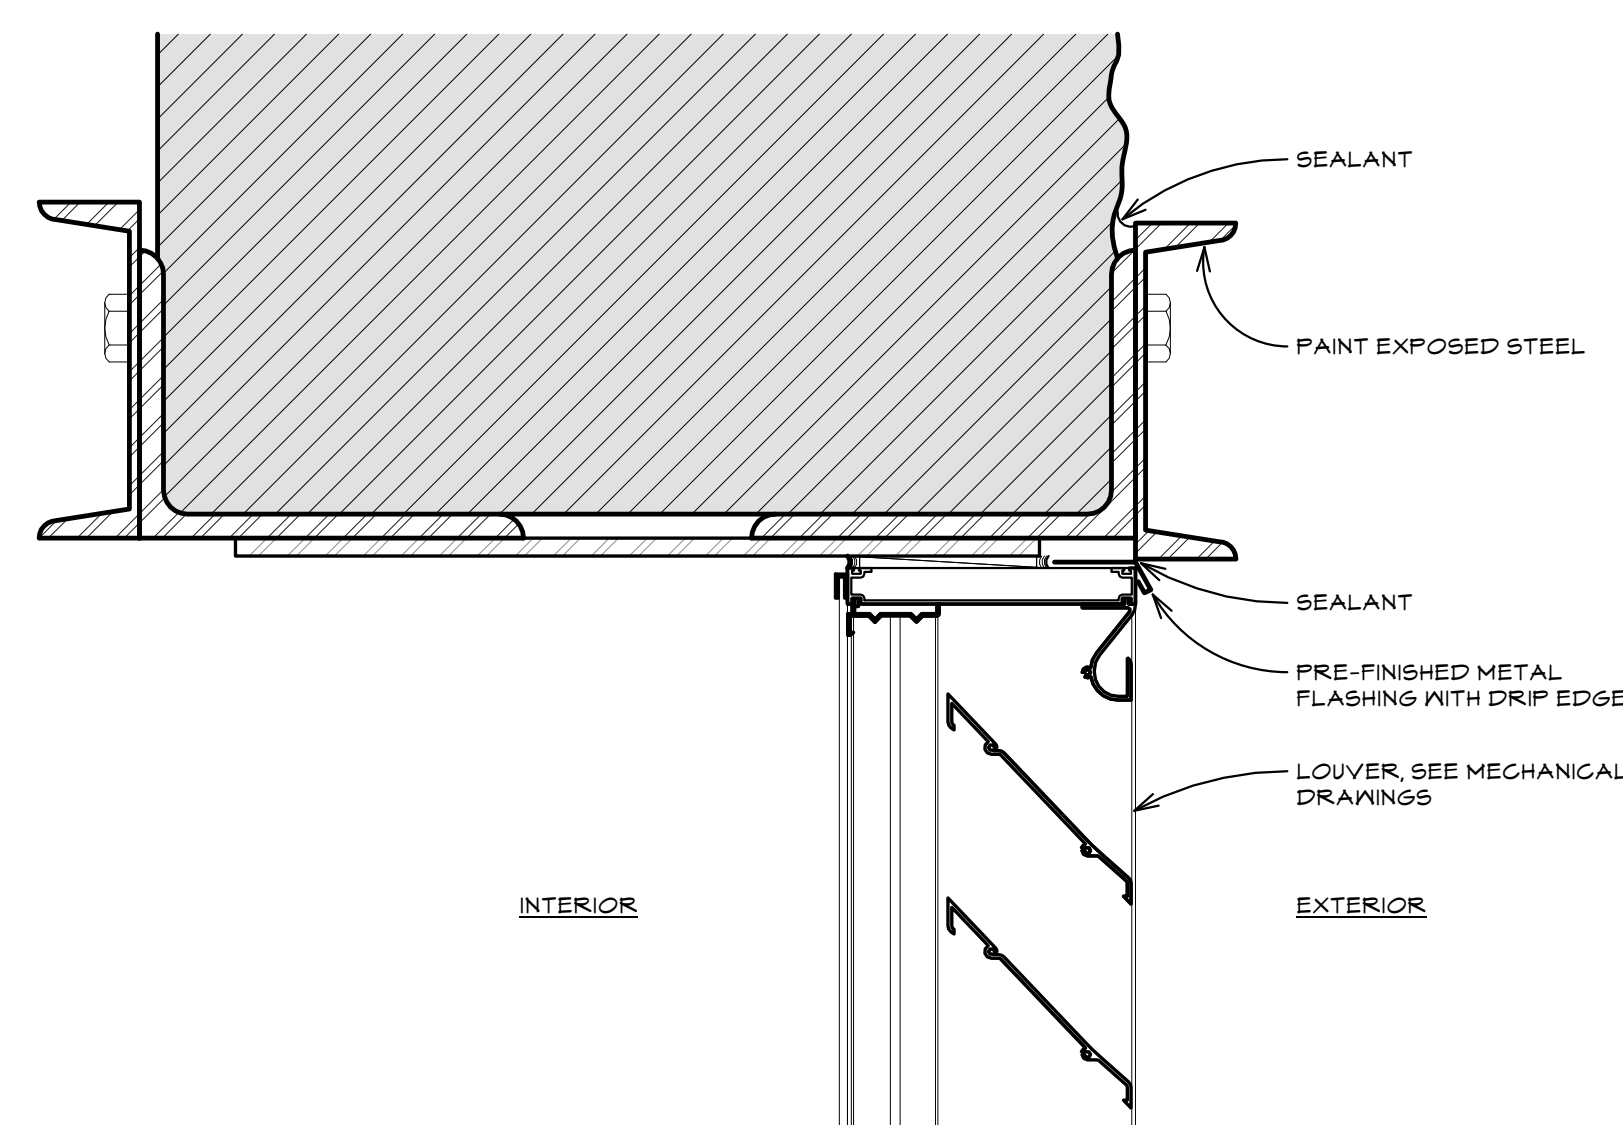

1 LOUVER HEAD
SCALE: 3" = 1'-0"

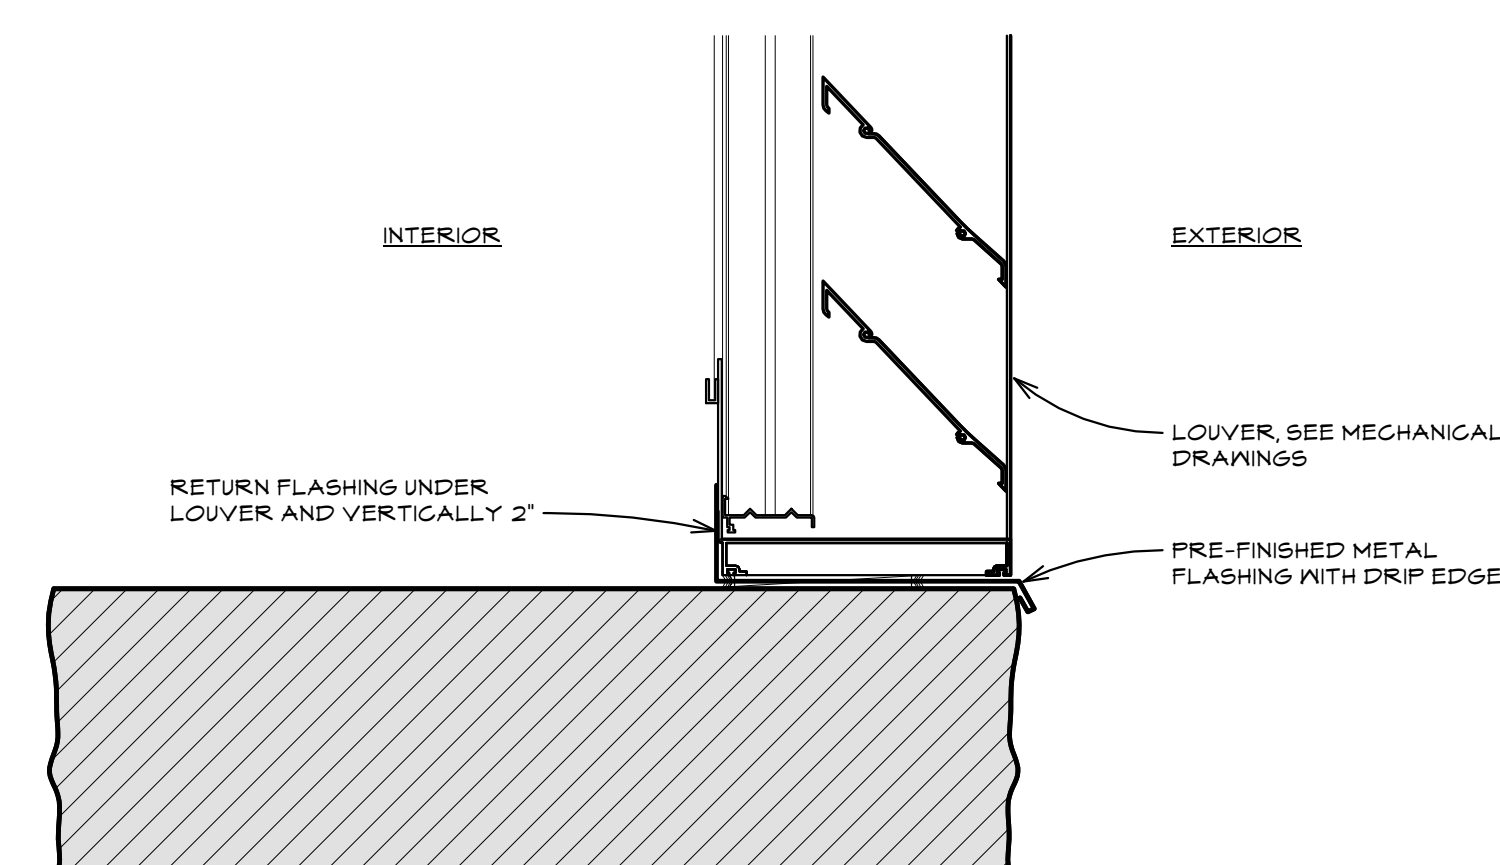

2 LOUVER SILL
SCALE: 3" = 1'-0"

OLD STONEY REMODEL
PHASE ONE
108 NORTH 4TH STREET
SUNDANCE, WYOMING 82729



PROJECT NUMBER
16-022

DATE
11-20-2017

DRAWN BY
KFOX
A WILLIAMSON

DISK ID.
16-022 Old
Stoney/16-022_Old
Stoney.rvt

SHEET TITLE
SOUTH BUILDING
ELEVATION

SHEET NUMBER

5.15